# **Selwyn Street Industrial**

# **Concept Design**

Project Location: 20 Selwyn Street Mayfield East 2304 Client:

JBC Family Trust

### Drawing Catalogue: (survey by others)

SK-000	Cover
SK-001	Site Analysis Plan
SK-002	Site Plan
SK-003	Site Plan 1:250
SK-004	Ground Floor Plan
SK-005	Roof Plan
SK-006	Elevations
SK-007	Elevations
SK-008	Section A-A





**SUBJECT SITE - NTS** 

Department of Planning,

NSW

Signed: BM Sheet No: 1 of 19

issued under the En

Approved on: 1 April 2025

Approved Application No: DA 24/14866

Housing and Infrastructure

ning and Assessment Act 1979

LOCATION - NTS

**Site Information** 

Client Site Address

LGA Land Zoning Precinct FSR/Site Coverag **Maximum Height** 

Flood Area **Mine Subsidence Bushfire Area** Heritage Area



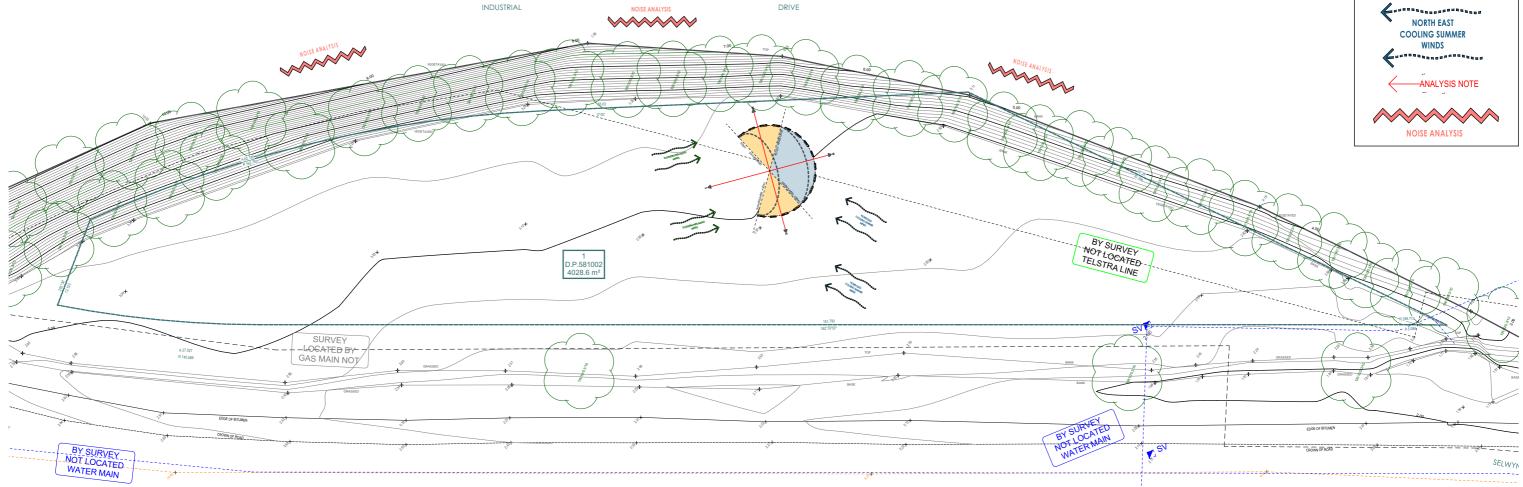
e: info@shadedesign.net.au

m: 0412 879 643

JBC Family Trust 20 Selwyn Street Mayfield East 2304 Sec -, Lot 1, DP 581002, SP -

	Newcastle
	SP1
	Limited
je	NA
t	NA
	NA
e Area	NA
	NA
	NA



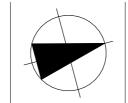


	SITE ANALYSIS
1:500	

Project Selwyn Street Industrial

20 Selwyn Street Mayfield East 2304

**Client** JBC Family Trust



Drawing Site Analysis Plan

Drawing No. SK-001

Project Number 2253

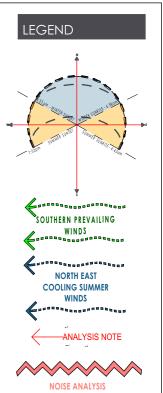
As Shown @ A3

Scale

Revision Α В C D

Description
Council Submission
RFI Amendment
RFI Amendment
RFI Amendment

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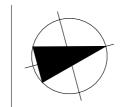
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**Dimensions.Guide** SETBACKS ARE APPROXIMATES ONLY & BASED OF CURRENT Semi-Trailer Truck (40' WB) Turning Paths **V** BEFORE CONSTRUCTION. SURVEYORS DOCUMENTATION AT THE TIME OF BEING ISSUED TO THE DESIGNER WITH THE CONCEPT DESIGNS - ALL SITE BOUNDARIES ARE TO BE CONFIRMED BY THE ALL SUBJECTS TO COMPETE APPLICATION FOR RELAXATION IS TO BE APPLIED FOR AS
 PART OF BUILDING APPROVAL.
 BUILDER AND/OR CERTIFYING AUTHORITY TO NOTIFY BUILDING DESIGNER JOEL SURVEYOR PRIOR TO & DURING CONSTRUCTION ALL SETBACKS ARE TO BE CONFIRMED ON SITE BY THE II II DIAL1100 SURVEYOR PRIOR TO & DURING CONSTRUCTION COLEMAN OF ANY DISCREPANCIES PRIOR TO APPROVAL. - DOWNPIPE POSITIONS ARE INDICATIVE ONLY, POSITION OF DOWNPIPES TO BE CONFIRMED BY BUILDER. ALL LOCATIONS AND POSITIONS TO COMPLY WITH BCA SECTION 3.5.3 TO BE CONFIRMED BY BUILDER & READ IN CONJUNCTION WITH ANY SITE/SURVEY DISCREPANCIES ARE TO BE REPORTED TO **BEFORE YOU DIG** SHADE DESIGN NEWCASTLE PTY LTD IMMEDIATELY HYDRAULIC ENGINEERS DETAILS & SPECIFICATION. **SURVEY BY OTHERS** INDUSTRIAL DRIVE ROOF OVER SCAFFOLD LAYDOWN STORAGE AREA 1500 m4 INFORMAL PARKING AREA FOR STAFF AND VEHICLE TBY SURVEY Θ PROPOSED DRIVEWAY TELS PALINE 5 D.P.581002 4028.6 m<sup>2</sup> Ð 355 m4 3.300 DECK 80 ing labor paint labor labor labor labor 1027 (Hot (1028 (Hot )Hot ) ¢. ٥ SURVEY 3.800 (1.000 LOCATED BY GAS MAIN NOT BELECTED 2400mm HIGH MESH WIRE BOUNDARY FENCE PROPOSED VEHICLE CROSSING TO SURRENT COLINCIL RECYCLEMENT GARDEN BED BETWEEN FENCE BY SURVEY NOT LOCATED NOT LOCATED NOT LOCATED WATER MAIN BY SURVEY NOT LOCATED WATER MAIN 1<sup>S</sup> SELWYN STREET

	Site Plan
1:500	

Project Selwyn Street Industrial 20 Selwyn Street Mayfield East 2304

Client JBC Family Trust



Drawing Site Plan

Drawing No. SK-002

Project Number 2253

Revision	Description
A	Council Submission
В	RFI Amendment
С	RFI Amendment
D	RFI Amendment

Department of Planning,

Issued under the Environmental Planning and Assessment Act 1979

Approved Application No: DA 24/14866

Approved on: 1 April 2025

NSW

Signed: BM Sheet No: 3 of 19

Housing and Infrastructure

Scale As Shown @ A3

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NOTES:

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 BOUNDARY INFORMATION PRIOR TO CONTRACTS AND/OR COMMENCEMENT OF WORK. - ALL SETBACKS TO COMPLY WITH LOCAL REQUIREMENTS UNLESS NOTED ON THIS SHEET.

### LEGEND

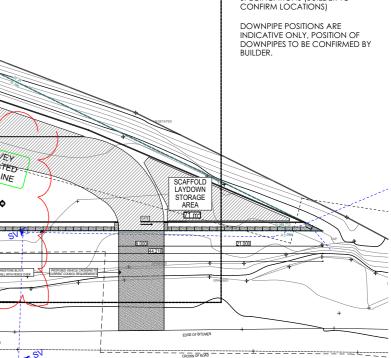
Site Area	4028.6m²
Total Floor Area (GFA)	NA
Floor Space Ratio (0.0 Max. = -m²)	NA
SP1 - Limited Growth	
landscape Area (00% Min Req. = -m²)	<b>NA</b> NA
<b>Deep Soil Area</b> (00% Min Req.)	<b>NA</b> NA

### STORMWATER

PLEASE REFER TO CONSULTING ENGINEERS DRAWINGS FOR STORMWATER DETAILS AS REQUIRED

### NOTES

VERTICAL CONTROL JOINTS INDICATIVE ONLY LOCATED IN ALL EXTERNAL WALLS 5000-6000mm CTS MAX AS PER ENGINEERS SPECIFICATIONS (BUILDER TO

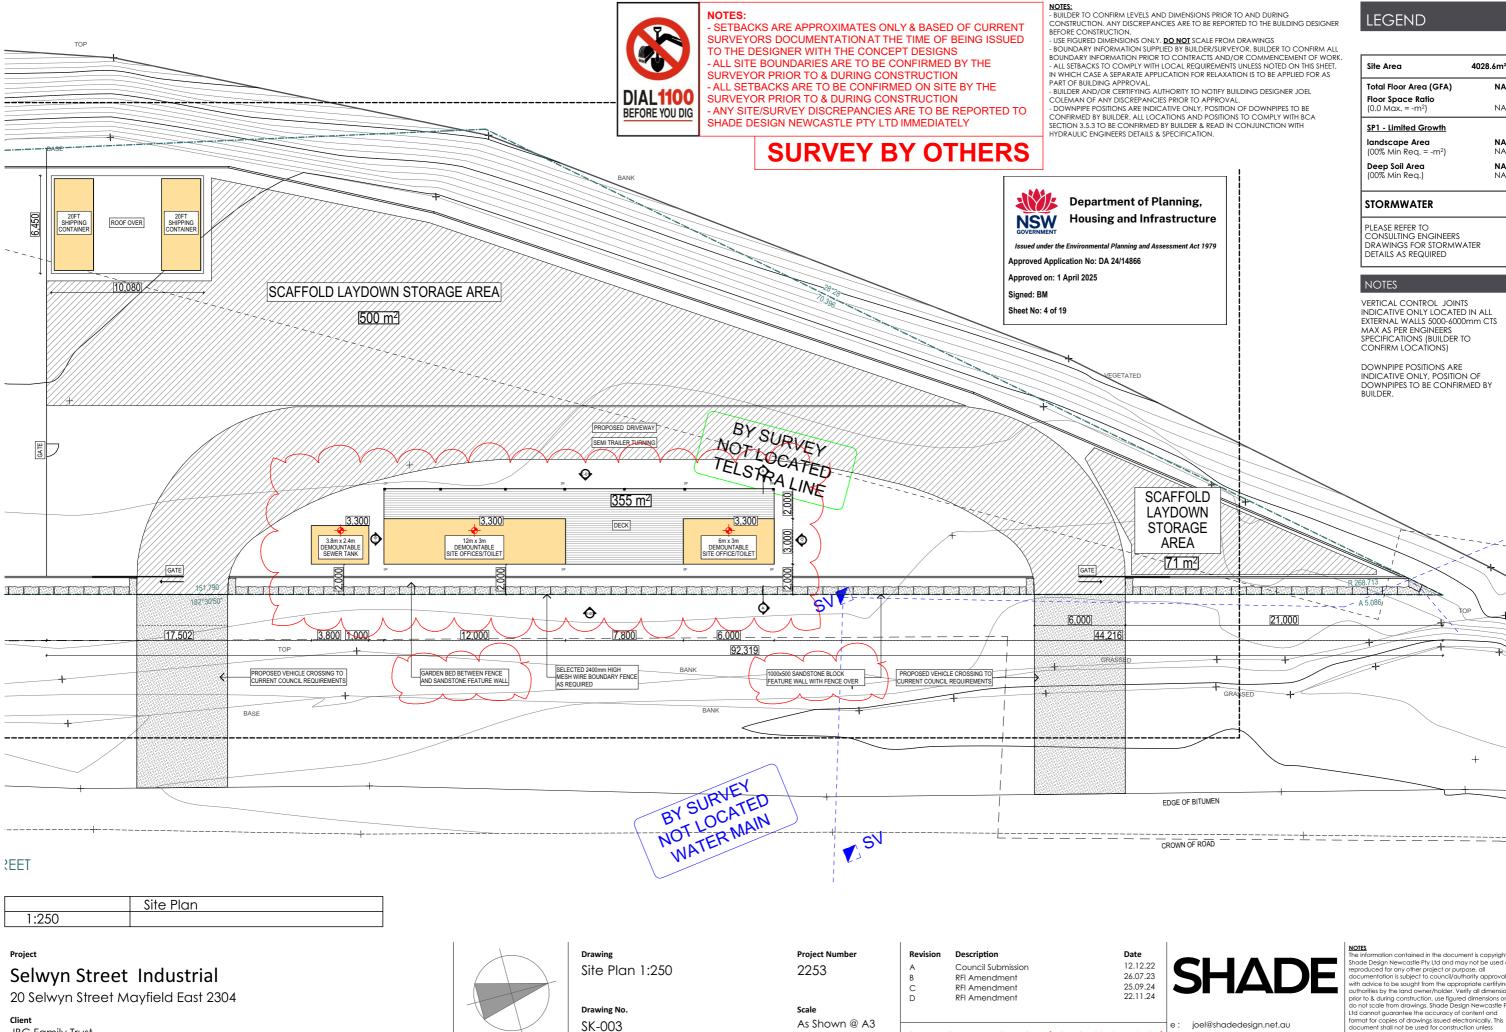




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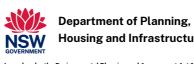


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Site Area	4028.6m²
Total Floor Area (GFA) Floor Space Ratio	NA
(0.0 Max. = -m <sup>2</sup> )	NA
SP1 - Limited Growth	
landscape Area (00% Min Req. = -m²)	<b>NA</b> NA
<b>Deep Soil Area</b> (00% Min Req.)	<b>NA</b> NA

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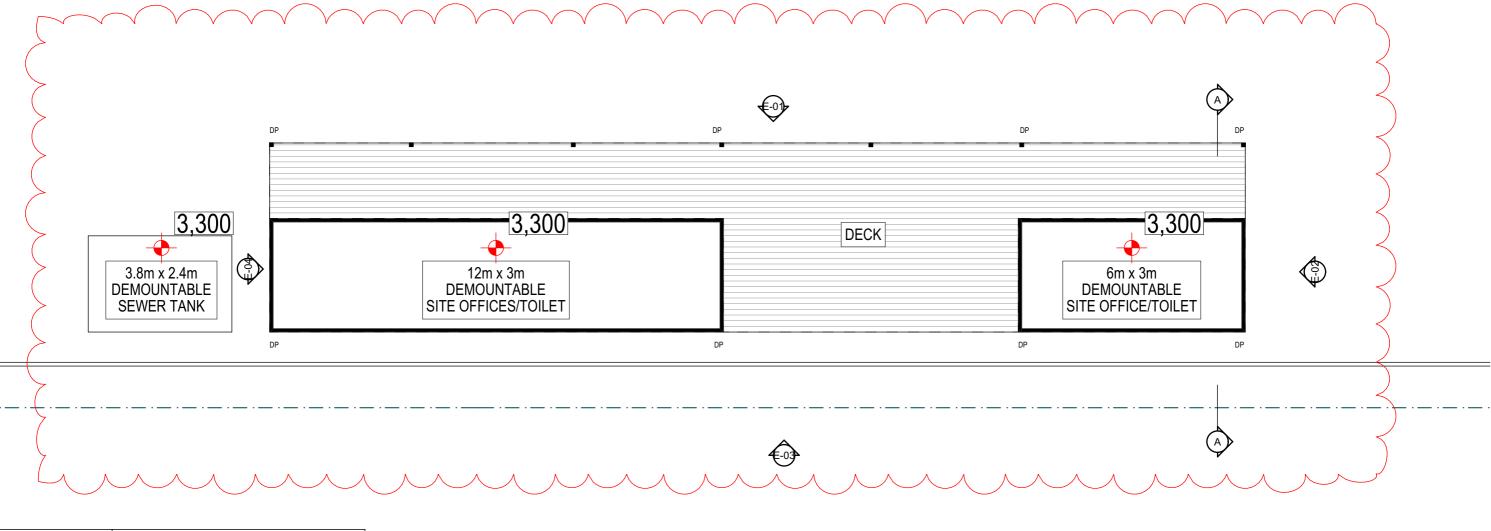
Housing and Infrastructure

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Approved on: 1 April 2025

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Sheet No: 5 of 19

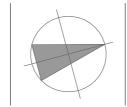


	Ground Floor Plan
1:100	

Project Selwyn Street Industrial

20 Selwyn Street Mayfield East 2304

**Client** JBC Family Trust



Drawing Ground Floor Plan

Drawing No. SK-004

Project Number 2253

As Shown @ A3

Scale

Revision Α В C D

Description Council Submission **RFI** Amendment **RFI** Amendment **RFI** Amendment

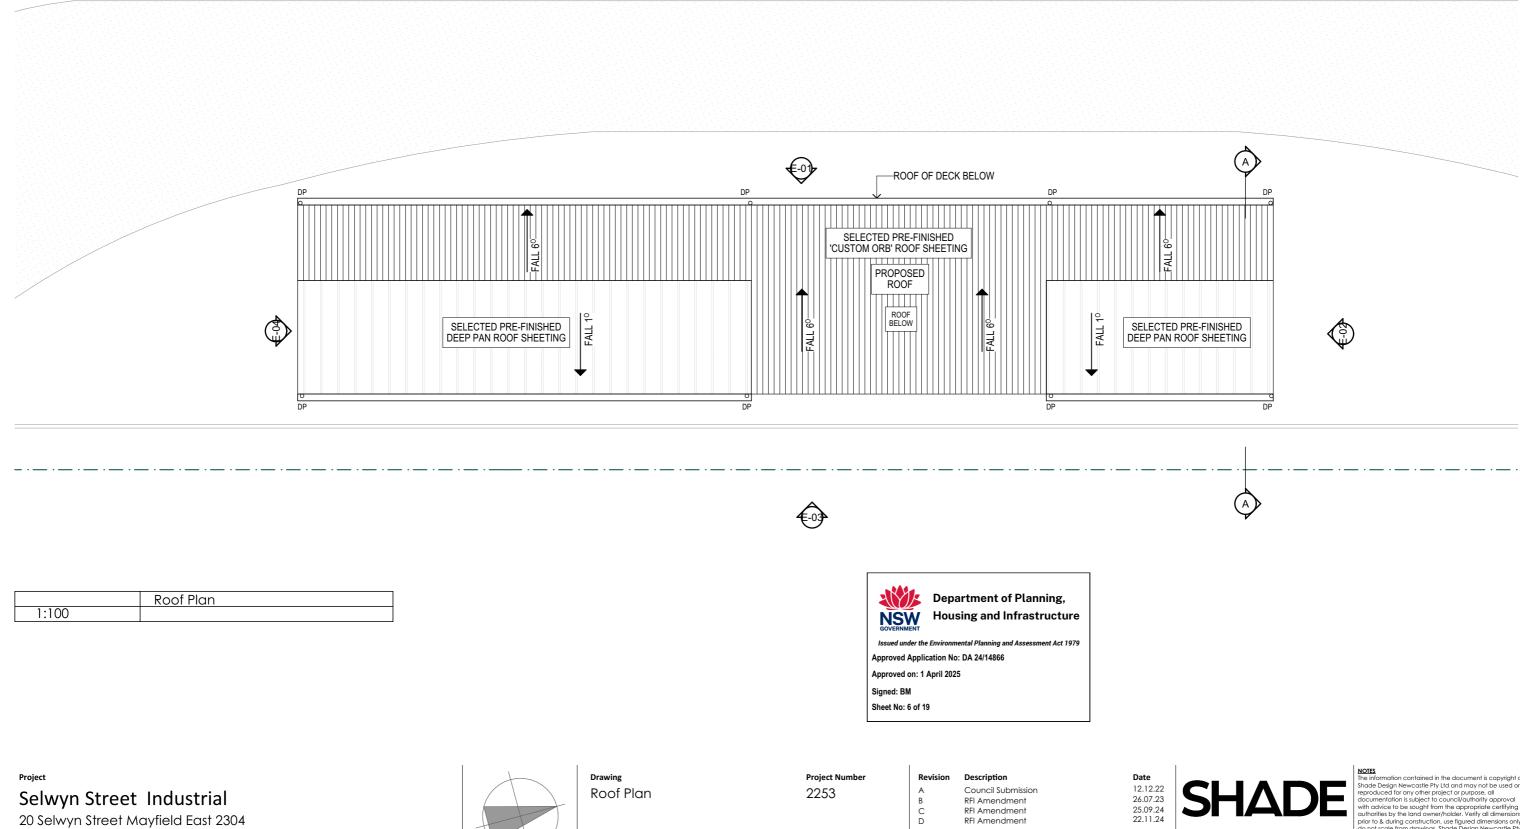
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Drawing No. SK-005

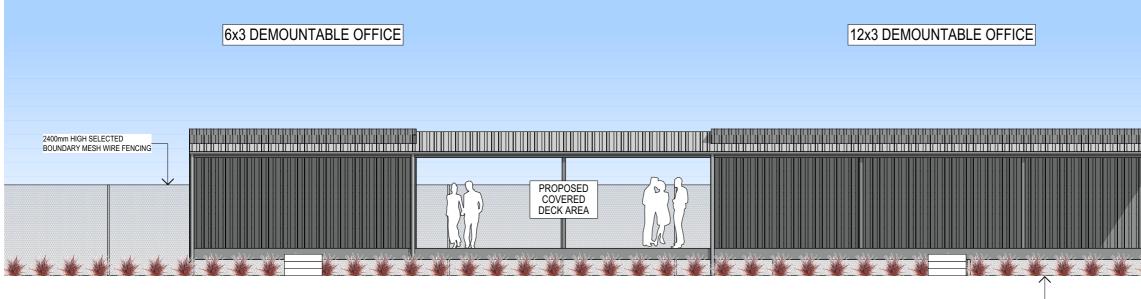
evision	Description
	Council Submission
	RFI Amendment
2	RFI Amendment
)	RFI Amendment

Scale As Shown @ A3

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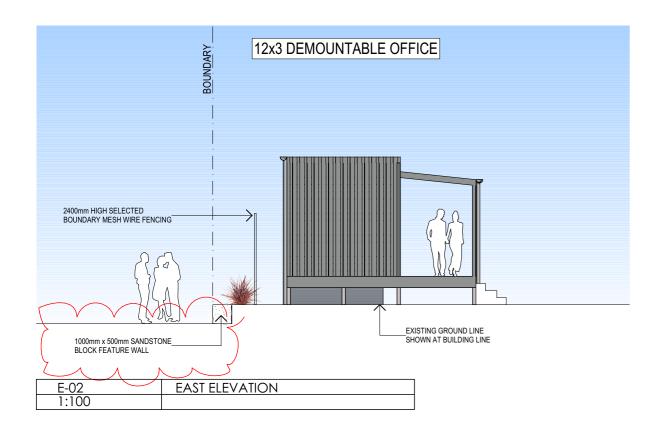
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EXISTING GROUND LINE SHOWN AT BUILDING LINE

E-01	NORTH ELEVATION
1:100	





Housing and Infrastructure

nt Act 1979

Approved Application No: DA 24/14866 Approved on: 1 April 2025 Signed: BM

Sheet No: 7 of 19

Project Selwyn Street Industrial

20 Selwyn Street Mayfield East 2304

Client JBC Family Trust Elevations

Drawing

Drawing No. SK-006

Project Number 2253

As Shown @ A3

Scale

Description Revision Council Submission **RFI** Amendment В **RFI** Amendment D **RFI** Amendment

Date 12.12.22 26.07.23 25.09.24 22.11.24



### LEGEND



SELECTED COLORBOND CUSTOM ORB METAL ROOF SHEETING

SELECTED FACE BRICKWORK



SELECTED WEATHERBOARD CLADDING TO LIGHTWEIGHT STRUCTURE



SELECTED LIGHTWEIGHT VERTICAL WALL CLADDING

SELECTED APPLIED FINISH

### NOTES

VERTICAL CONTROL JOINTS INDICATIVE ONLY LOCATED IN ALL EXTERNAL WALLS 5000-600 mm CTS MAX AS PER ENGINEERS SPECIFICATIONS (BUILDER TO CONFIRM LOCATIONS)

DOWNPIPE POSITIONS ARE INDICATIVE ONLY, POSITION OF DOWNPIPES TO BE CONFIRMED BY BUILDER.

### CONFIRM BUILDING DIMENSIONS PRIOR **TO & DURING CONSTRUCTION**

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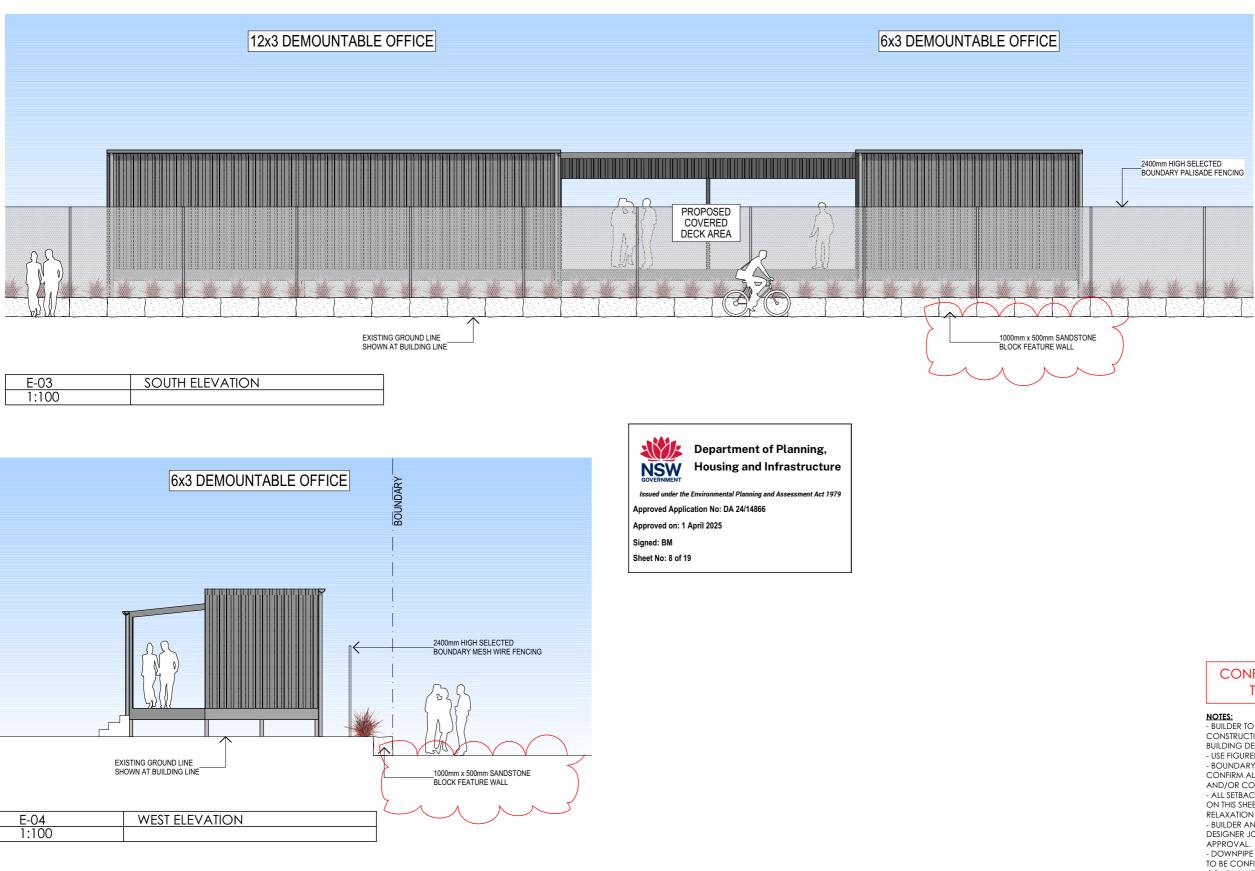
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Project Selwyn Street Industrial

20 Selwyn Street Mayfield East 2304

Client JBC Family Trust Drawing No.

SK-007

Elevations

Drawing

Project Number 2253

Scale

Description Revision Council Submission **RFI** Amendment В **RFI** Amendment D **RFI** Amendment

Date 12.12.22 26.07.23 25.09.24 22.11.24

### LEGEND



SELECTED COLORBOND CUSTOM ORB METAL ROOF SHEETING

SELECTED FACE BRICKWORK



SELECTED WEATHERBOARD CLADDING TO LIGHTWEIGHT STRUCTURE



SELECTED LIGHTWEIGHT VERTICAL WALL CLADDING

SELECTED APPLIED FINISH

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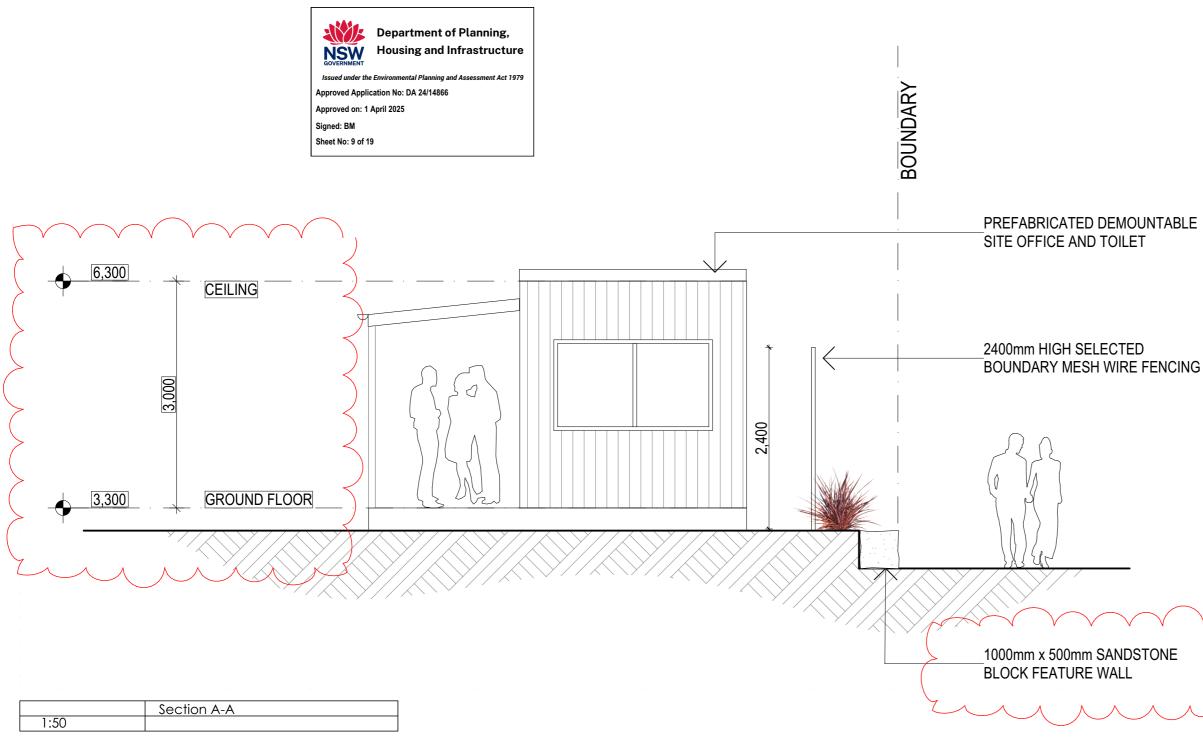
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### NOTES

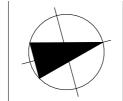
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Project Selwyn Street Industrial

20 Selwyn Street Mayfield East 2304

Client JBC Family Trust



Drawing Section A-A

Drawing No. SK-008

Project Number 2253

Scale

В D

Revisio

n	Description	
	Council Submission	
	RFI Amendment	
	RFI Amendment	
	RFI Amendment	

Date 12.12.22 26.07.23 25.09.24 22.11.24

As Shown @ A3

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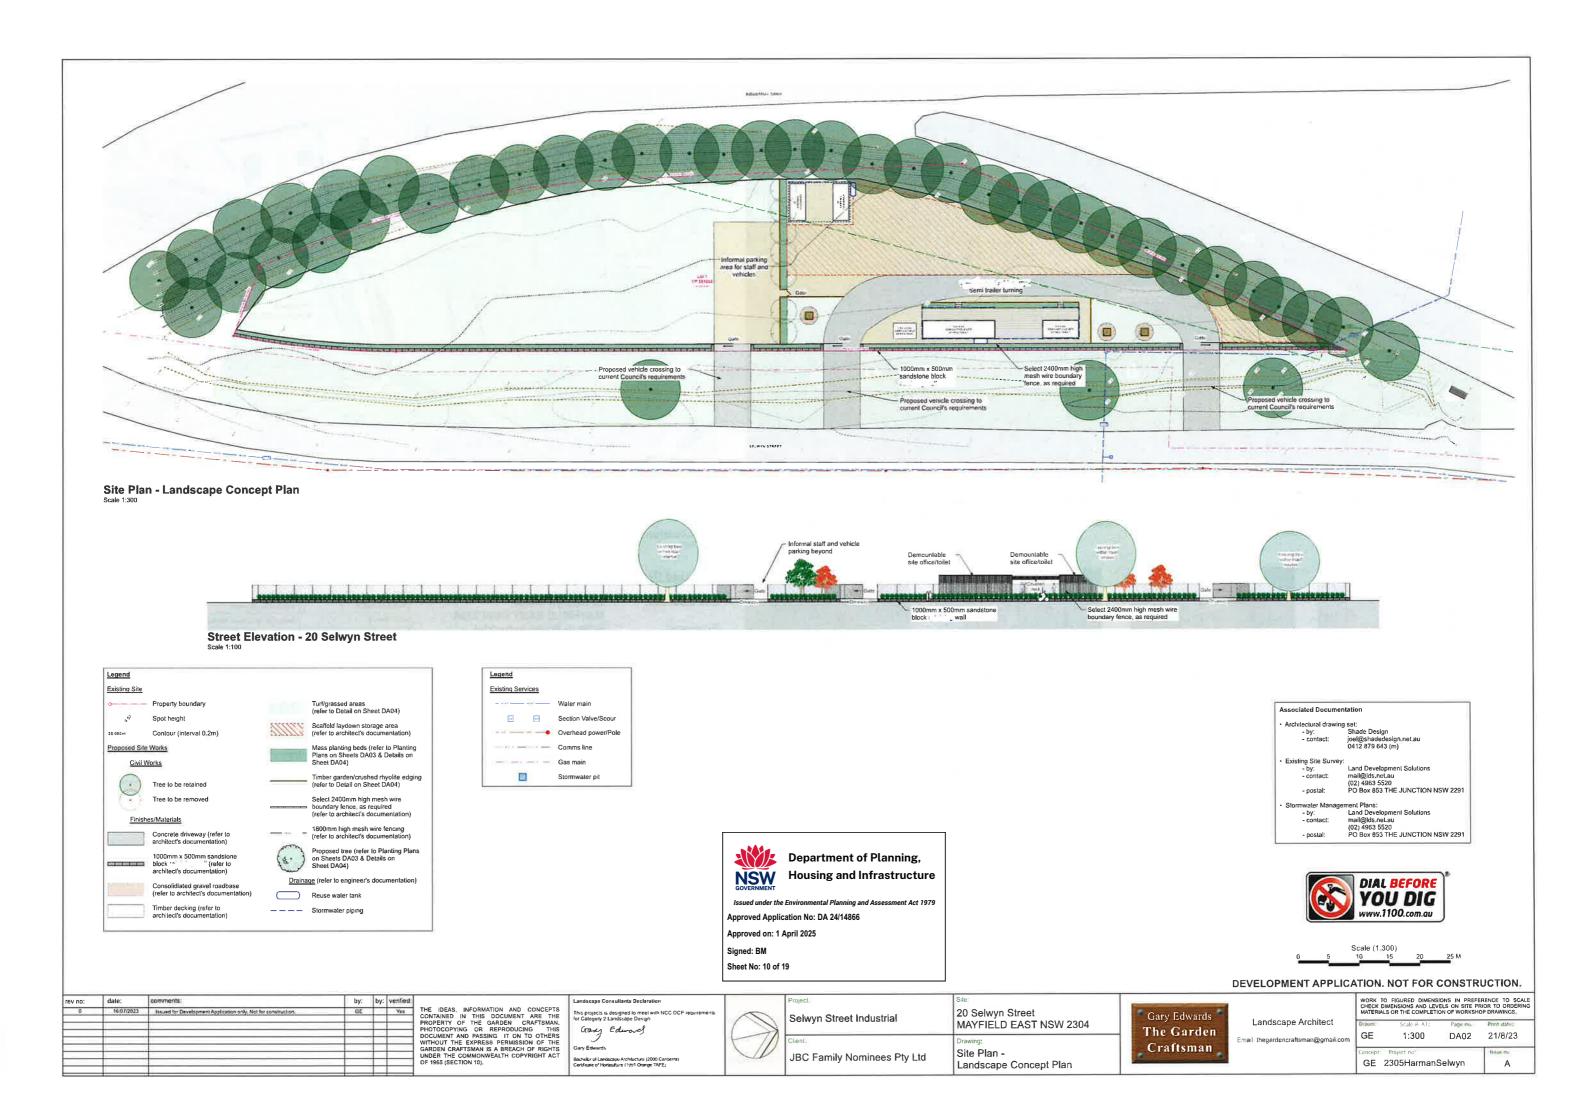
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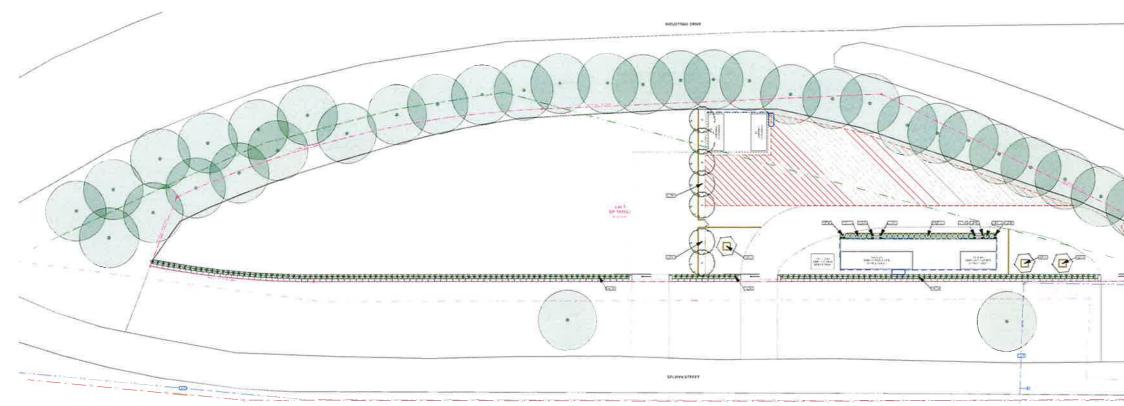


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# Planting Plan - Site Trees, Shrubs & Groundcovers Scale 1:300

ID	Quantity	Botanical Name	Common Name	Height	Spread	Pot size
CLJ	24	Callistemon 'Little John'	Dwarf Bottlebrush	1.0m	1.0m	140mm
Cv	3	Callistemon viminalis	Weeping Bottlebrush	10.0m	4.0m	45Lt
LI	178	Lomandra longifolia	Mat Rush	1.0m	1.0m	140mm
LIT	13	Lomandra longifolia 'Tanika'	Tanika Mat Rush	0.5m	0.5m	Tubestock
TH.	7	Tristaniopsis laurina 'Luscious'	Luscious Water Gum	8.0m	5.0m	45L1

Plant Schedule - Site Trees, Shrubs & Groundcovers











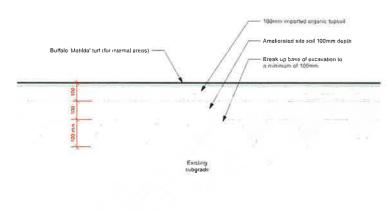
Lomandra longifolia (Mat Rush)

	Department of Planning, Housing and Infrastructure				
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Approved Application No: DA 24/14866					
Approved on: 1 April 2025					
Signed: BM					
Sheet No: 11 of 1	19				

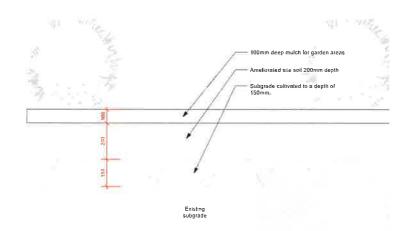


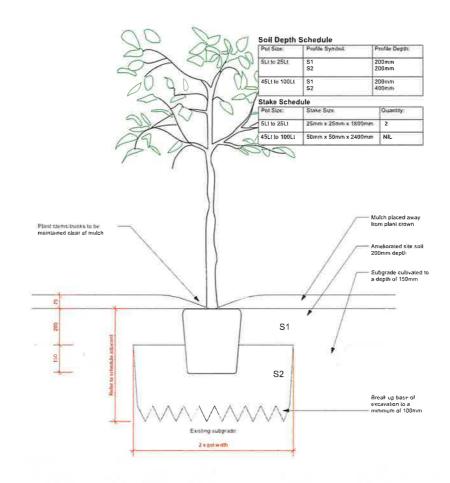
ev no:	date:	comments:	by:	by: verified		Landscape Consultants Declaration	1	Project:	Site:	
Q	16/07/2023	Issued for Development Application only. Not for construction,	GE	Yes	THE IDEAS, INFORMATION AND CONCEPTS CONTAINED IN THIS DOCUMENT ARE THE PROPERTY OF THE GARDEN CRAFTSMAN. PHOTOCOPYING OR REPRODUCING THIS	This projects is designed to meet with NCC DCP requirements for Category 2 Landscape Design Group Edward		Selwyn Street Industrial	20 Selwyn Street MAYFIELD EAST NSW 2304	Gary Edward
					DOCUMENT AND PASSING IT ON TO OTHERS WITHOUT THE EXPRESS PERMISSION OF THE GARDEN CRAFTSMAN IS A BREACH OF RIGHTS UNDER THE COMMONWEALTH COPYRIGHT ACT OF 1965 (SECTION 10).	Gary Edwards Bacheko el Landscape Arch fecture (2000 Canberna) Centí care el Horizudarie (1991 Orange TAFE)	D	Clent: JBC Family Nominees Pty Ltd	Drawing: Planting Plan - Site Trees, Shrubs & Groundcovers	Craftsman

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) <sup>®</sup> <sup>2</sup> DEVELOPMENT APPLICA	Scale (1:100) <u>4 6 8 10 M</u> ATION. NOT FOR CONSTR	
S Landscape Architect Email: thegardencraftsman@gmail.com	WORK TO FIGURED DIMENSIONS IN PREFE CHECK DIMENSIONS AND LEVELS ON SITE PR MATERIALS OR THE COMPLETION OF WORKSHE Drawn: Scale & AT; Page row, GE 1:100 DA03 Concept: Project no: GE 2305HarmanSelwyn	RENCE TO SCALE IOR TO ORDERING IP DRAWINGS. Print lafe: 21/8/23 hsie ne. A

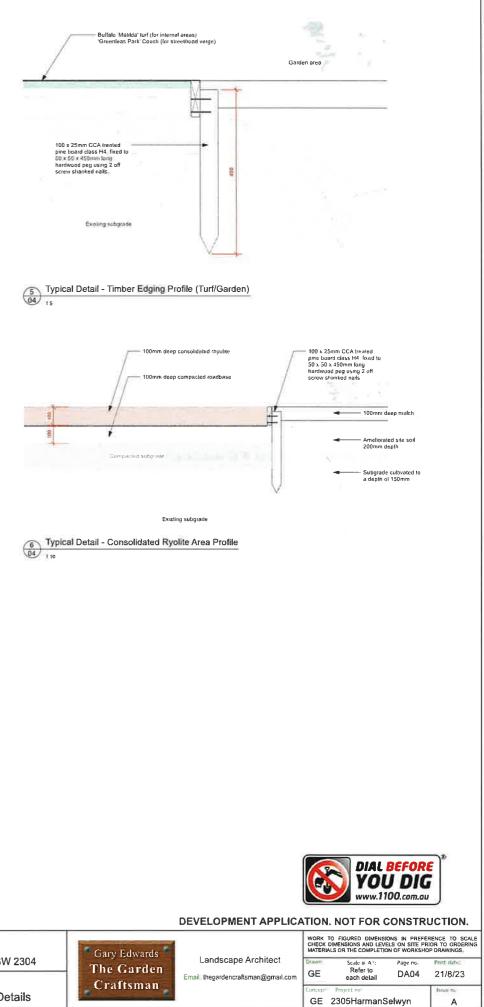


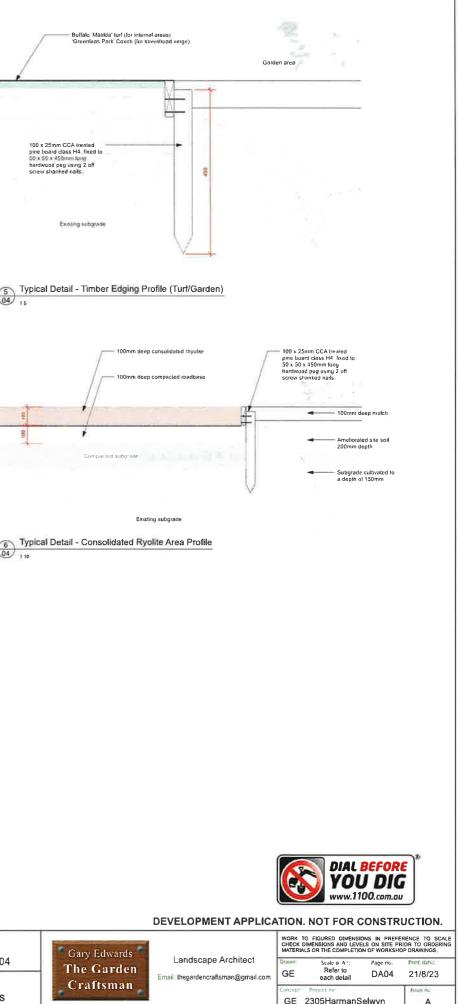
Typical Detail - Turf Profile





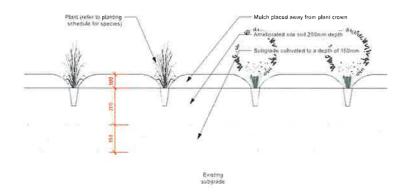
(4) Typical Detail - Tree Planting Within Garden Areas





Typical Detail - Garden Area Profile

Typical Detail - Planting Setout





NSW Housing and Infrastructure

Issued under the Environmental Planning and Assessment Act 1979 Approved Application No: DA 24/14866 Approved on: 1 April 2025 Signed: BM

Sheet No: 12 of 19

by: by: verified: GE Yes rev no: date: comments: andscape Consultants Declaration ojeci THE IDEAS, INFORMATION AND CONCEPTS CONTAINED IN THIS DOCUMENT ARE THE PROPERTY OF THE GARDEM CRAFTSMAN, PHOTOCOPYING OR REPRODUCING THIS DOCUMENT AND PASSING IT ON TO OTHERS WITHOUT THE EXPRESS PERMISSION OF THE GARDEN CRAFTSMAN IS A BREACH OF RIGHTS UNDER THE COMMONWEALTH COPYRIGHT ACT OF 1985 (SECTION 10). 16/07/2023 Insued for Development Application only. Not for construction. This projects is designed to meet with NCC DCP re-for Category 2 Landscape Design 20 Selwyn Street Selwyn Street Industrial MAYFIELD EAST NSW 2304 Grany Edward Drawing: Lont Gary Edwards JBC Family Nominees Pty Ltd Bachelor of Landscape Architecture (2009 Canberra) Certificate of Horbculture (1991 Drange TAFE) Site Construction Details

- Erosion & Sediment Control Plan or Soil & Water Management Plan
   An Erosion and Sediment Control Plan or Soil and Water Management Plan shall be submitted. The plan shall contain information required for the area of disturbance of the development or its distinct and separate stages in accordance with Development Control Plan 2014.
   The final plan shall include a signed and dated Statement of Compliance stating (in full):
   a) This plan has been developed, certified and signed off by an appropriately qualified and experienced professional in erosion and sediment control;
   b) The plan complies with the requirements for the area of disturbance in accordance with Development Control Plan 2014;
   c) The plan and associated documents, calculations and drawings, have been prepared to a standard which, if properly implemented, shall achieve the water release criteria of 50mg/L of total suspended solids (TSS); and diversion, and sediment control masures are in accordance in Control Plan 2014. d) All erosion and sediment control measures are in accordance with Development Control Plan 2014.

Hoarding and Construction Site Safety Fencing • Construction site safety fencing and/or hoarding shall be provided in accordance with WorkCover requirements, Such fencing and/or hoarding shall be rerected wholly within the property boundary unless prior approval from Council is obtained. • Council approval is required to install hoarding, site fencing or overhead protective structures over or adjoining a public place i.e. a footpath or a Public Reserve. No work shall commence until written approval is obtained.

Dial Before You Dig (Advice)
Prior to commencement of work, the free national community service "Dial Before You Dig" shall be contacted on 1100 regarding the location of underground services in order to prevent injury, personal liability and even death. Enquiries shall provide the property details and the nearest cross street/road,

### **Erosion and Sediment Control**

 The size and location of a sediment trap/basin shall be determined prior to any activities, including demolition which would result in soil disturbance, based on site conditions in accordance with DCP 2014. The sediment trap/basin shall be installed and operational prior to any soil disturbance.
 Appropriate erosion and sediment controls shall be installed in accordance with Development Control Plan 2014.
 All disturbed areas shall be revegetated or rendered erosion resistant in accordance with Development Control Plan 2014.
 All disturbed areas shall be revegetated or rendered erosion resistant in accordance with Development Control Plan 2014.
 All disturbed areas shall be revegetated or rendered erosion resistant in accordance with Development Control Plan 2014. The Blue Book 4th Edition, Landcom, 2004.

- Existing Trees

   Refer to Arborist Report, if available, for specifications for all existing trees.
   The existing trees to be retained on site are to be protected by surrounding with a 1.8m high chainmesh fence 3.00m from the base of the tree.
   This fence is to be erected prior to works commencing on site and is to be retained until all building works are completed.
- The enclosed area is to remain free of materials, machinery, vehicles or site sheds.

### Initial Preparation

- The planting area must be free from any existing grass, particularly couch grass. Mechanical removal to be employed prior to planting and mulching.
   Excess soils and contaminated soil are to be removed within the guidelines of the council requirements to approved sites,
   Refer to Arborist Report for the location of existing trees to be removed and protection of existing trees to be retained,

### Licensed Contractor

All landscape works shall be implemented under the full supervision of a contractor with a current NSW Department of Fair Trading endorsed license in Structural Landscaping.

### Soil Preparation

- Cultivate all subsoil areas to a depth of 150mm.
- Cultivate garden depth to 200mm and 100mm depth in all lawn areas; add a clay breaker to all garden areas.
- Remove excess day, where required, to another excess day, where excess day, where required, to another excess day, where required, to another excess day, where excess day, where required, to another excess day, where excess day, where required, to another excess day, where excess day, where required, to another excess day, where excess da
- depths to enable lawn and plants to thrive and grow.
   Ensure soil levels are set to allow for the addition of turf and mulches to specified requirements.

### Planting of Trees, Shruhs, Grasses and Groundcovers

- Landscape works shall conform to planting densities as scheduled with all plants at nominated pot sizes and spacing's and be maintained for a minimum of 52 weeks to achieve continuous healthy growth.
   Ensure plants are installed within 24hrs of delivered.
- Set out plants as indicated on Planting Plans (refer to Sheets DA03) & Construction Details (refer to Sheet DA04).
- · Add fertilizer, followed by 100mm of garden soil shall be placed into the base of hole and lightly consolidated. · Base of stem shall finish flush with finished soil level.
- Thoroughly water all plants on first planting to soak soil of plant and surrounding soil so as to allow roots to adjust, do not allow drying out.
   Water regular over the first 3-4 weeks.
- Suppress all new weeds, within planting areas, that may arise throughout the contract.

- Mulching

   Install 100mm minimum of forest mulch over all gardens area (refer to Sheet DA04), to aid plant establishment, covering mulch around all plants keeping
- away from stems and finishing flush with adjacent surfaces. · Please Note: Narrow spaces between timber retaining walls and Lot Boundary fencing, where planting is not to occur, are to be mulched as per instructions

Specifications Notes

### Turf Areas All internal lurf areas to have suitable Buffalo 'Matilda' instant turf laid over prepared subsoils Refer to Sheet DA04 for turf area details.

Timber Edging
• Min. 50mm x 100mm H4 treated pine timber edge to be located between all garden/turf areas & gravel/crushed rhyolite areas. Secure to 50mm x 50mm x 450mm hardwood timber pegs with galvanised nails. 2 per fixing.
• Refer to Sheet DA04 for timber edging area details.

### Fencing Refer to Architect's Documentation for all fencing details.

### Excavation & Retaining

Refer to Engineer's & Architectural Documentation for all excavation & retaining details. Only retaining walls indicated on the approved plans shall be constructed under this consent. No additional excavation/fill shall occur outside the area as shown on the approved plans.

No fill or training walls shall be located within any drainage easement located upon the subject property.
 Retaining walls, footings and associated drainage works shall be located wholly within the subject property boundaries and shall be connected to the existing stormwater system or other approved stormwater system on the subject property.

Drainage

 Refer to Hydraulic Engineer's Documentation for all drainage details. · All drainage works shall be carried out in accordance with the approved Construction Certificate plans.

Landscape Compliance Report

All the completion of landscape works, the consulting landscape architect who prepared the documentation shall submit to the Certifying Authority a Landscape Compliance Report. This report shall certify shrub and tree species, pot size, and planting densities and landscape area setout comply with these conditions and approved

This report shall certify required street frees are planted specifically as per the nominated locations on the approved documentation and these conditions, and practical completion of the landscaping works has occurred.
 This report shall certify required street frees are planted specifically as per the nominated locations on the approved documentation and these conditions, and have ediging constructed as per the Lake Macquarie CIty Council Landscape Standard Drawings March 2019.
 The Certifying Authority shall not issue the Final Occupation Certificate without receipt of the Landscape Compliance Report.

### Maintenance & Handover

Maintenance of a period of 52 weeks shall be carried out after the submission of the Landscape Compliance Report.

· All landscape works required under this consent shall undergo an establishment maintenance period of a minimum of 52 weeks to achieve the intent of the

All landscape works shall be carried out/overseen by members of Landscape NSW & ACT Master Landscapers Association and implemented under the full

All antiscape works sinal be control or an appropriately qualified landscape contractor.
 All landscape works to be maintained to achieve continuous healthy growth improving amenity and aesthetics over the site and meeting the aims for the

development in the zone

acveopment in the zone. • Satisfy council that all landscaping work has been undertaken in strict accordance with council's landscape codes and guidelines, • At the completion of landscape works and prior to the issue of the Occupation Certificate a Landscape Compliance Report is required that establishes satisfactory completion of the landscape works approved. • This report shall state the actual maintenance carried out on site, including maintenance records such as site work report sheets, diary entries or log books

In all areas where fill is required, gain required levels using an organic soil mix,
which show frequency of watering, weeding, mulching, personnel and any other remediation or rectification works carried out.
Remove excess clay, where required, to allow for addition of 200mm depth of premium organic garden soil to garden areas and 100mm depth of topsoil to
Carry out the following during the maintenance period (determined by Builder). These works shall include but not limited to watering, weeding, eritilizing. pest and disease control, re-turling, staking and tying, replanting, cultivation, pruning, aerating, renovation, top dressing and the like.

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Housing and Infrastructure

Issued under the Environmental Planning and Assessment Act 1979

rev no:	date:	comments:	by:	by: ve	rified:		Landscape Consultants Declaration	Project:	Sile	
0	16/07/2023	Issued for Development Application only, Not for construction,	GE		_	PROPERTY OF THE GARDEN CRAFTSMAN. PHOTOCOPYING OR REPRODUCING THIS	This projects is designed to meet with NCC DCP requirements for Category 2 Landscape Design	Selwyn Street Industrial	20 Selwyn Street MAYFIELD EAST NSW 2304	Gary Edward
						DOCUMENT AND PASSING IT ON TO OTHERS WITHOUT THE EXPRESS PERMISSION OF THE GARDEN CRAFTSMAN IS A BREACH OF RIGHTS UNDER THE COMMONWEALTH COPYRIGHT ACT OF 1965 (SECTION 10).	Gary Edwards Bachelor of Landscape Architecture (2000 Candenni) Centificata of Horidukure (1991 Orange TA/E)	Glent: JBC Family Nominees Pty Ltd	Drawing: Site Construction Notes	Craftsman

## Department of Planning,

Approved Application No: DA 24/14866

Approved on: 1 April 2025

Signed: BM

Sheet No: 13 of 19



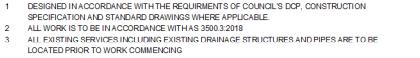
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mail; thegardencraftsman@gmail.com	GE	Refer to each delail	DA05	21/8/23	
	Concept:	Project no:		have no	

GE 2305HarmanSelwyn

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- U-PVC PIPES TO BE SEWER GRADE DWV TO AS1260:2017
- MINIMUM PIPE FALLS: 1.0%
- DOWNPIPE & RAINWATER TANK LOCATIONS ARE DIAGRAMATIC ONLY AND FINAL LOCATIONS TO BE DETERMINED ONSITE BETWEEN THE PLUMBER AND THE OWNER. TANK MANUFACTURER, TYPE AND STYLE ETC TO BE NOMINATED BY THE CLIENT AT CC STAGE.
- MINIMUM NOMINATED CAPACITY TO BE INSTALLED. ALL PIPES TO BE 100Ø UPVC UNLESS NOTED OTHERWISE ON PLAN
- SEDIMENT AND EROSION CONTROLS TO BE PROVIDED IN ACCORDANCE WITH ALL LOCAL AND STATUTORY REGULATIONS
- REFER TO ARCHITECT FOR BUILDING AND DRIVEWAY SETOUT 10 PIPE POSITIONS ARE INDICATIVE ONLY. FINAL POSITIONS TO BE DETERMINED ON SITE AND 11 SHALL CONFORM WITH THE INTENT OF THIS DESIGN.
- THE ENGINEER SHALL BE ADVISED IF ANY EXISTING STRUCTURES ARE WITHIN THE ZONE OF 12 INFLUENCE OF ANY EXCAVATION. ANY REQUIRED UNDERPINNING OR PIERING SHALL BE PROVIDED
- WHERE EXCAVATING ADJACENT TO BOUNDARIES ADEQUATE SHORING SHALL BE PROVIDED 13 THE CONTRACTOR SHALL ENSURE THAT ALL NEW STRUCTURES ARE FOUNDED BELOW THE 14 ZONE OF INFLUENCE OF ANY EXCAVATIONS WHETHER THEY BE FOR PIPELINES, TANKS OR
- OTHER DRAINAGE FACILITIES UNLESS NOTED OTHERWISE, THE MAXIMUM DEVIATION FROM NOMINATED LEVELS SHALL BE +/-10MM, EXCEPT IN INSTANCES WHERE SUCH A DEVIATION COULD HAVE ADVERSE EFFECT, IN WHICH CASE, THE DESIGNER SHALL BE CONSULTED
- 16 LOAD CLASS FOR COVERS/GRATES SHALL BE IN ACCORDANCE WITH AS3996 - 1992. COMMON CASES FOR RESIDENTIAL SITES ARE SUMMARIZED IN THE FOLLOWING TABLE:

CLASS	LOADING	DESCRIPTION
A	10 KN	INACCESSIBLE TO VEHICLES.PEDESTRIAN TRAFFIC ONLY.
в	80 KN	FOR USE ON FOOTPATHS OR FOOTWAYS WHERE IT IS POSSIBLE FOR LIGHT VEHICLES OR LIVESTOCK TO USE PEDESTRIAN FACILITY.
с	150 KN	FOR USE IN PEDESTRIAN ACCESS WITH OCCASIONAL MOTOR VEHICLES WITH WHEEL LOADS NOT EXCEEDING 3.7 TONNES. <u>OR</u> FOR USE IN MINOR RESIDENTIAL ROADS & CUL-DE-SACS CARRYING SLOW MOOVING COMMERCIAL VEHICLES (GENERATING NO IMPACT LOADING) WHERE WHEEL LOADS WILL NOT EXCEED 7.5 TONNES

- UNTIL COMPLETION OF ALL WORKS. THE CONTRACTOR SHALL FIRSTLY FILTER ALL STORMWATER 17 IN ACCORDANCE WITH APPROVED DETAILS TO ENSURE THE REMOVAL OF ALL CONCRETE AND PLASTERING FINES, AND OTHER BUILDING SITE POLLUTANTS
- 18 THE CONTRACTOR SHALL ADEQUATELY SHIELD PIPES AGAINST CONSTRUCTION AND PERMANENT LOADS, WHERE ADEQUATE COVER CANNOT BE PROVIDED, PIPES SHALL BE ENCASED CONCRETE
- UNLESS NOTED OTHERWISE, WHERE A PIT INVERT IS BELOW THE INVERT OF THE LOWEST OUTLET 19 PIPE THE CONTRACTOR SHALL EITHER PROVIDE DRAINAGE HOLES IN THE BASE OF THE PIT OR ELSE FILL THE BASE OF THE PIT WITH MASS CONCRETE TO THE INVERT OF THE LOWEST OUTLET PIPE
- WHERE REQUIRED BY REGULATIONS, STEP IRONS IN ACCORDANCE WITH AS 1657 SHALL BE 20 INSTALLED IN DEEP PITS/TANKS TO ALLOW ACCESS FOR MAINTENANCE. PIT COVERS OVER DEEP PITS SHALL BE 'CHILD-PROOFED' BY BOLTING THEM DOWN, EXCEPT WHERE THE COVER WEIGHS OVER 30kg
- ALL IMPERVIOUS SURFACES SHALL BE GRADED SUCH THAT THEY ARE FREE DRAINING
- 22 YARD PITS SHALL BE PROVIDED AS REQUIRED. YARDS SHALL BE GRADED TO FALL TO PITS UNLESS INTRICATE OTHERWISE (EG. BY DESIGN CONTOURS, SPOT LEVELS OR A NOTE)
- 23 UPON COMPLETION, PIPE/PIT EXCAVATIONS SHALL BE BACKFILLED WITH SUITABLE MATERIAL AND COMPACTED TO A DENSITY EQUIVALENT TO THE SURROUNDING NATURAL MATERIAL
- 24 WHERE REQUIRED BY THE PRINCIPAL CERTIFY, WORK-AS-EXECUTED DETAILS SHALL BE PREPARED BY A REGISTERED SURVEYOR/CHARTED PROFESSIONAL ENGINEER VERIFYING THAT THE DRAINAGE SYSTEM HAS BEEN CONSTRUCTED IN ACCORDANCE WITH THE DRAWINGS, ANY DEVIATION FROM THE APPROVED PLANS SHALL BE NOTED AND BROUGHT TO THE ATTENTION OF THE DESIGNER. ADEQUATE INSPECTIONS SHOULD BE CARRIED OUT DURING THE COURSE OF CONSTRUCTION
- WHERE CERTIFICATION WILL BE REQUIRED, THE DESIGNER SHALL BE CALLED ON TO INSPECT 25 THE WORKS PRIOR TO ANY CONCRETE POURS, PRIOR TO BACKFILLING AROUND ANY TANKS, AND AT THE COMPLETION OF WORKS, THE DESIGNER SHALL BE GIVEN A MINIMUM OF 24 HOURS NOTICE BEFORE AN INSPECTION IS REQUIRED
- 26 ANY PROPOSED ALTERATIONS TO THE DETAILS SHOWN ON THE DRAWINGS SHALL BE SUBMITTED TO THE DESIGNER FOR APPROVA
- 27 LEAF SCREENS, SILT CONTROLS AND ANY OTHER POLLUTANT CONTROL DEVICES SHALL BE REGUARLY SERVICED TO ENSURE THAT THE DRAINAGE SYSTEM REMAINS UNBLOCKED AND OPERATED AS ORIGINALLY INTENDED
- OVERLAND FLOW PATHS SHALL BE REGUARLY MAINTAINED AND KEPT FREE OF OBSTRUCTIONS 28 TO THE FLOW OF WATER
- 29 SUBSOIL DRAINAGE LINES SHALL BE PROVIDED BEHIND RETAINING WALLS AND OTHER AREA AS REQUIRED TO RELIVE HYDROSTATIC PRESSURE AND DRAIN GROUND WATERS. CONNECT INTO THE DRAINAGE SYSTEM IN SUCH A WAY AS TO AVOID BLACKFLOW OF STORMWATER INTO THE SUBSOIL DRAINAGE LINE. IF IN DOUBT REFER TO ENGINEER.

AR PARKING AREA ADDED

DRAINS MODELLING UNDERTAKEN

Details of Revi

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VITIAL ISSUE

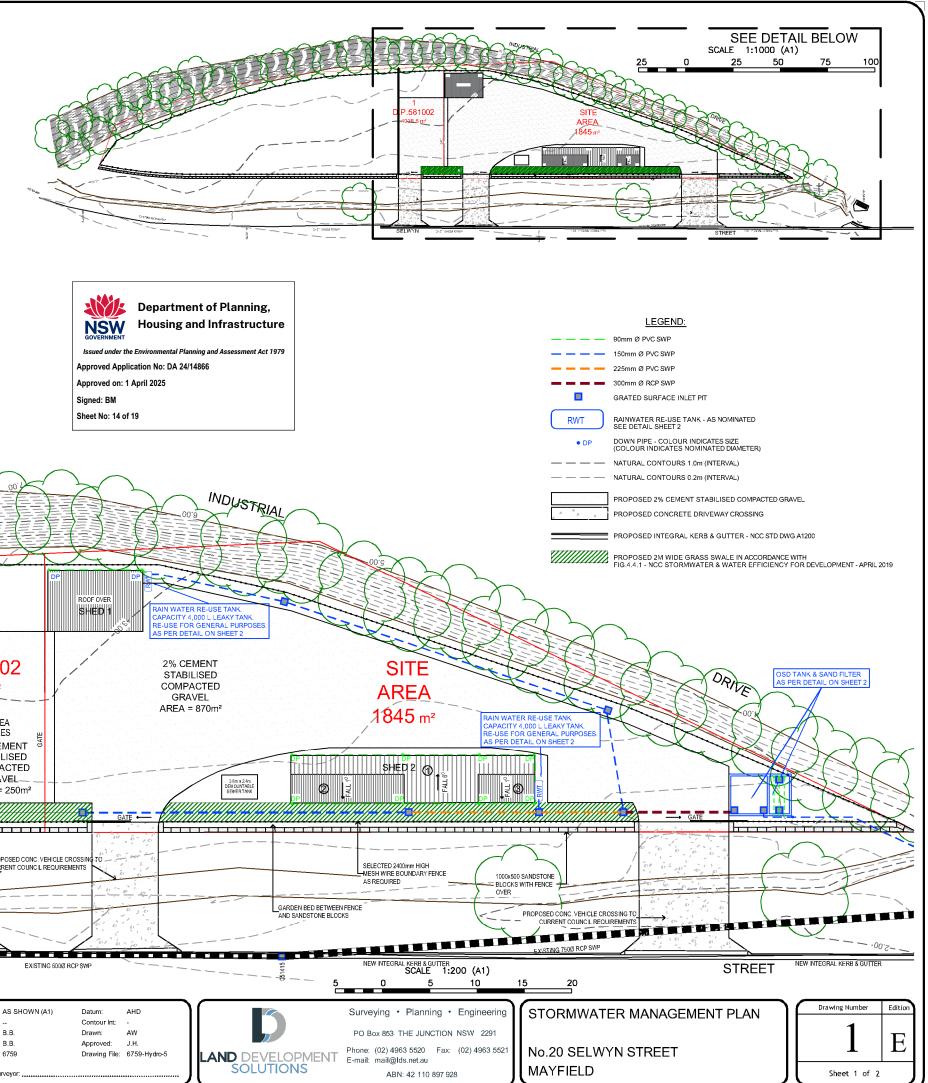
NEW FENCES, RETAINING WALL AND OTHER LANDSCAPING ITEMS SHALL BE DETAILED IN SUCH A 30 WAY SO AS TO AVOID IMPOUNDING OR DIVERTING SURFACE WATERS ONTO ADJOINING PROPERTIES.

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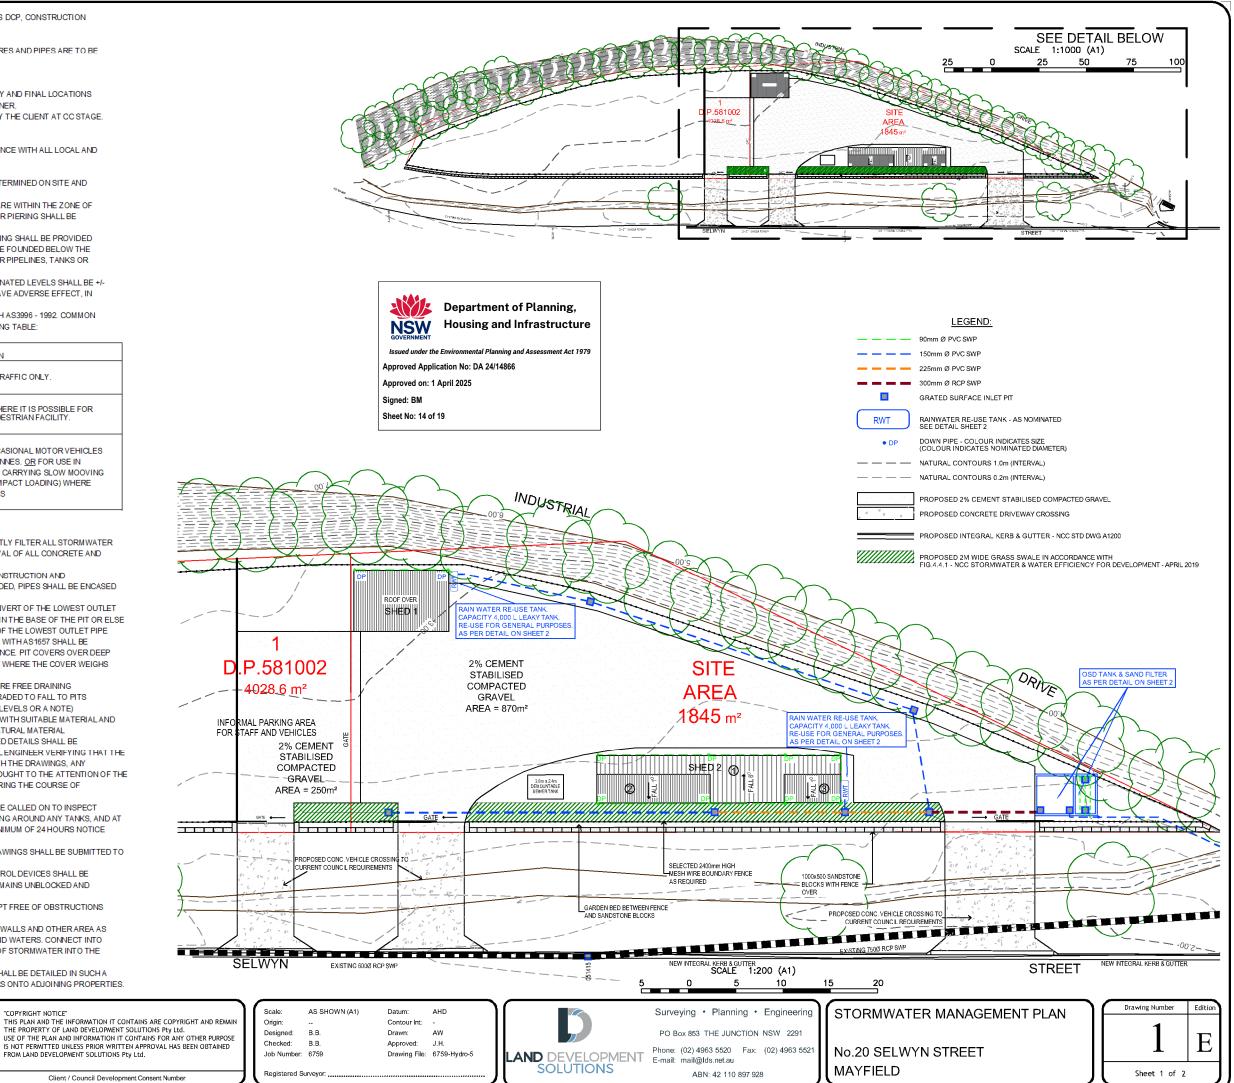
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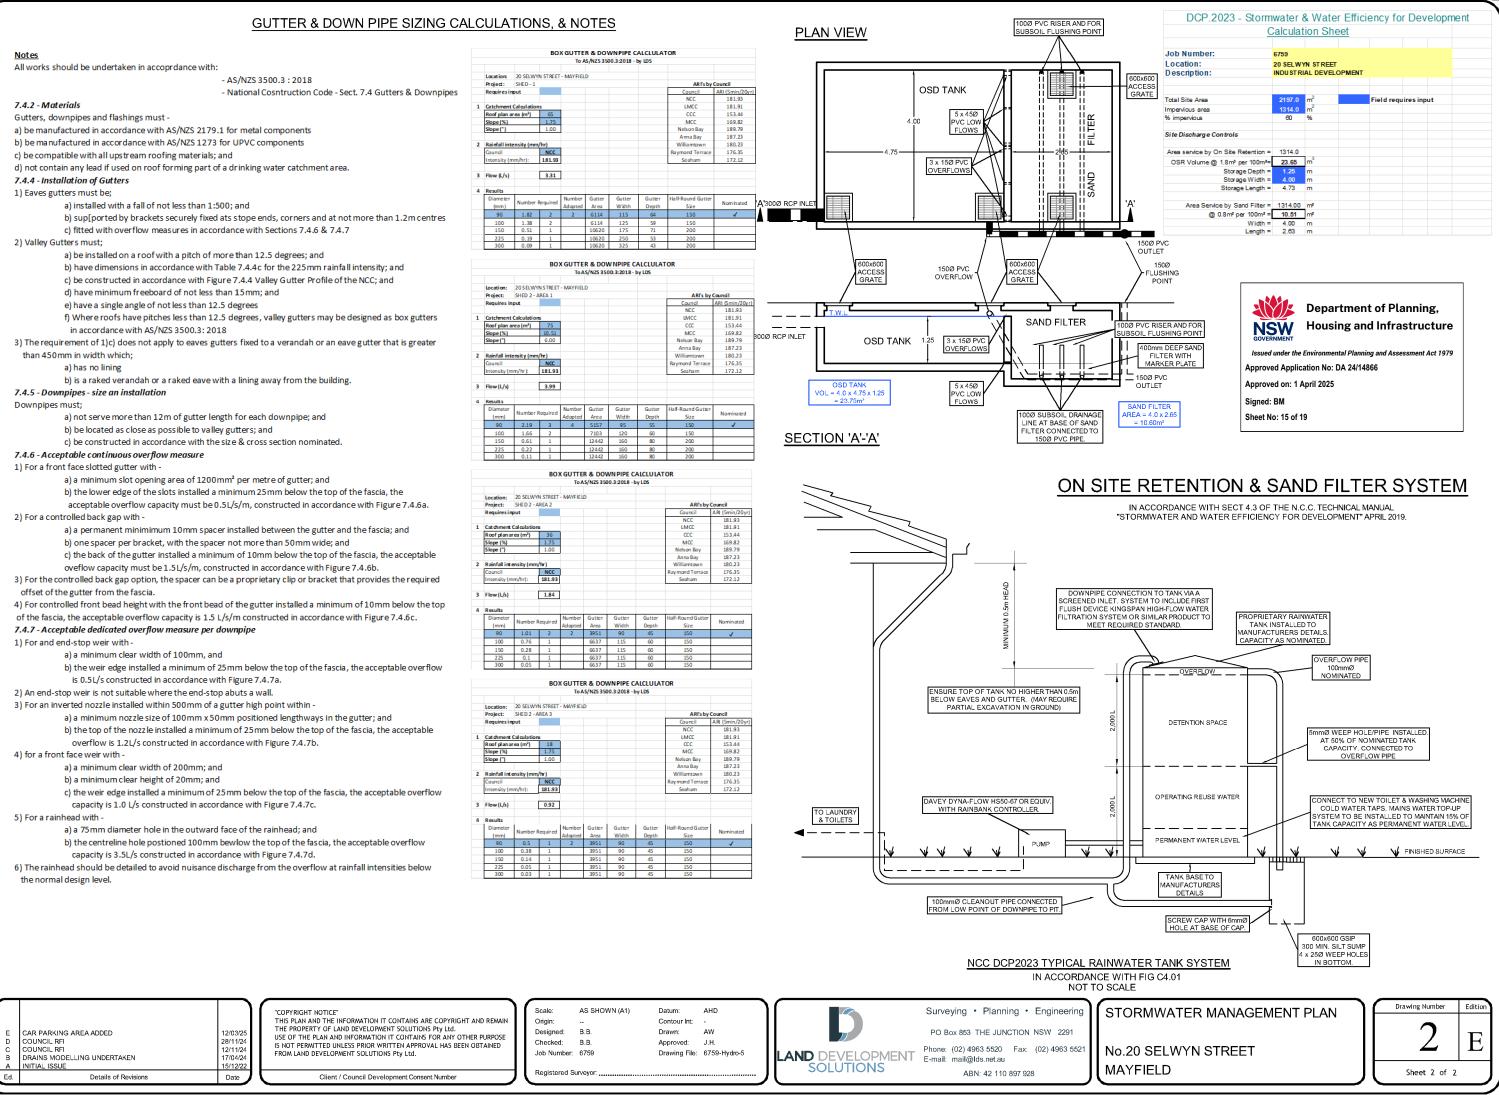
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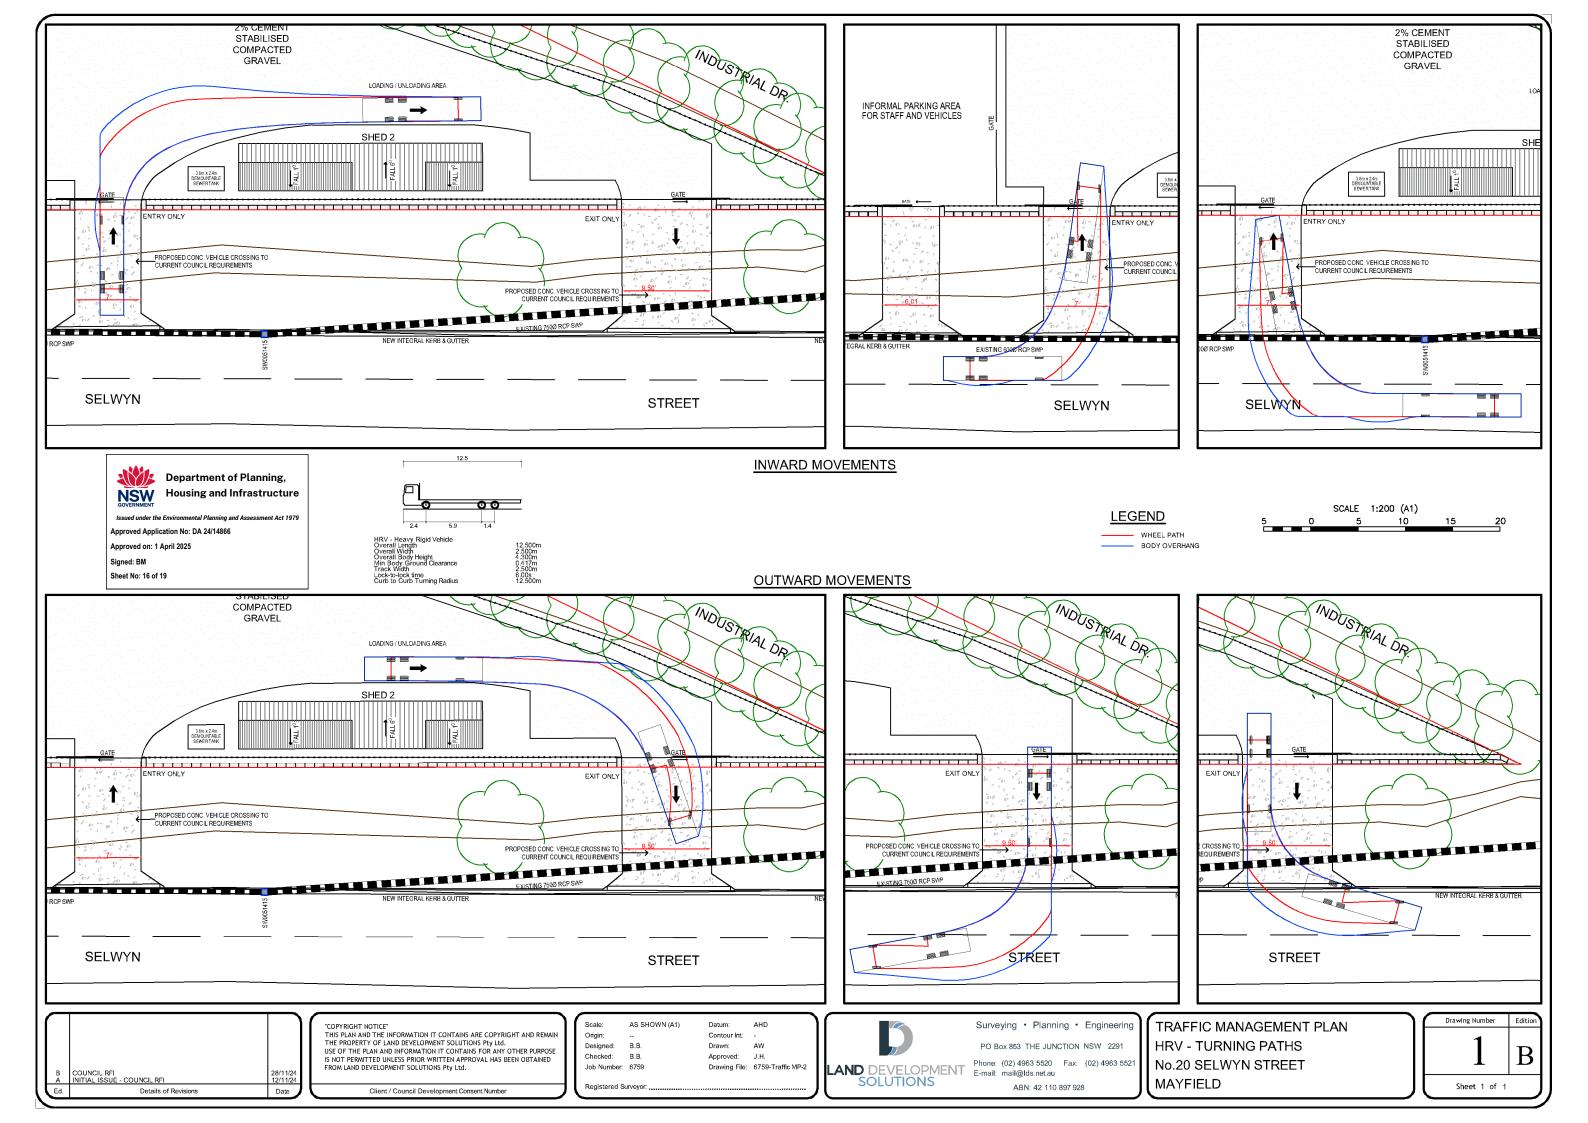


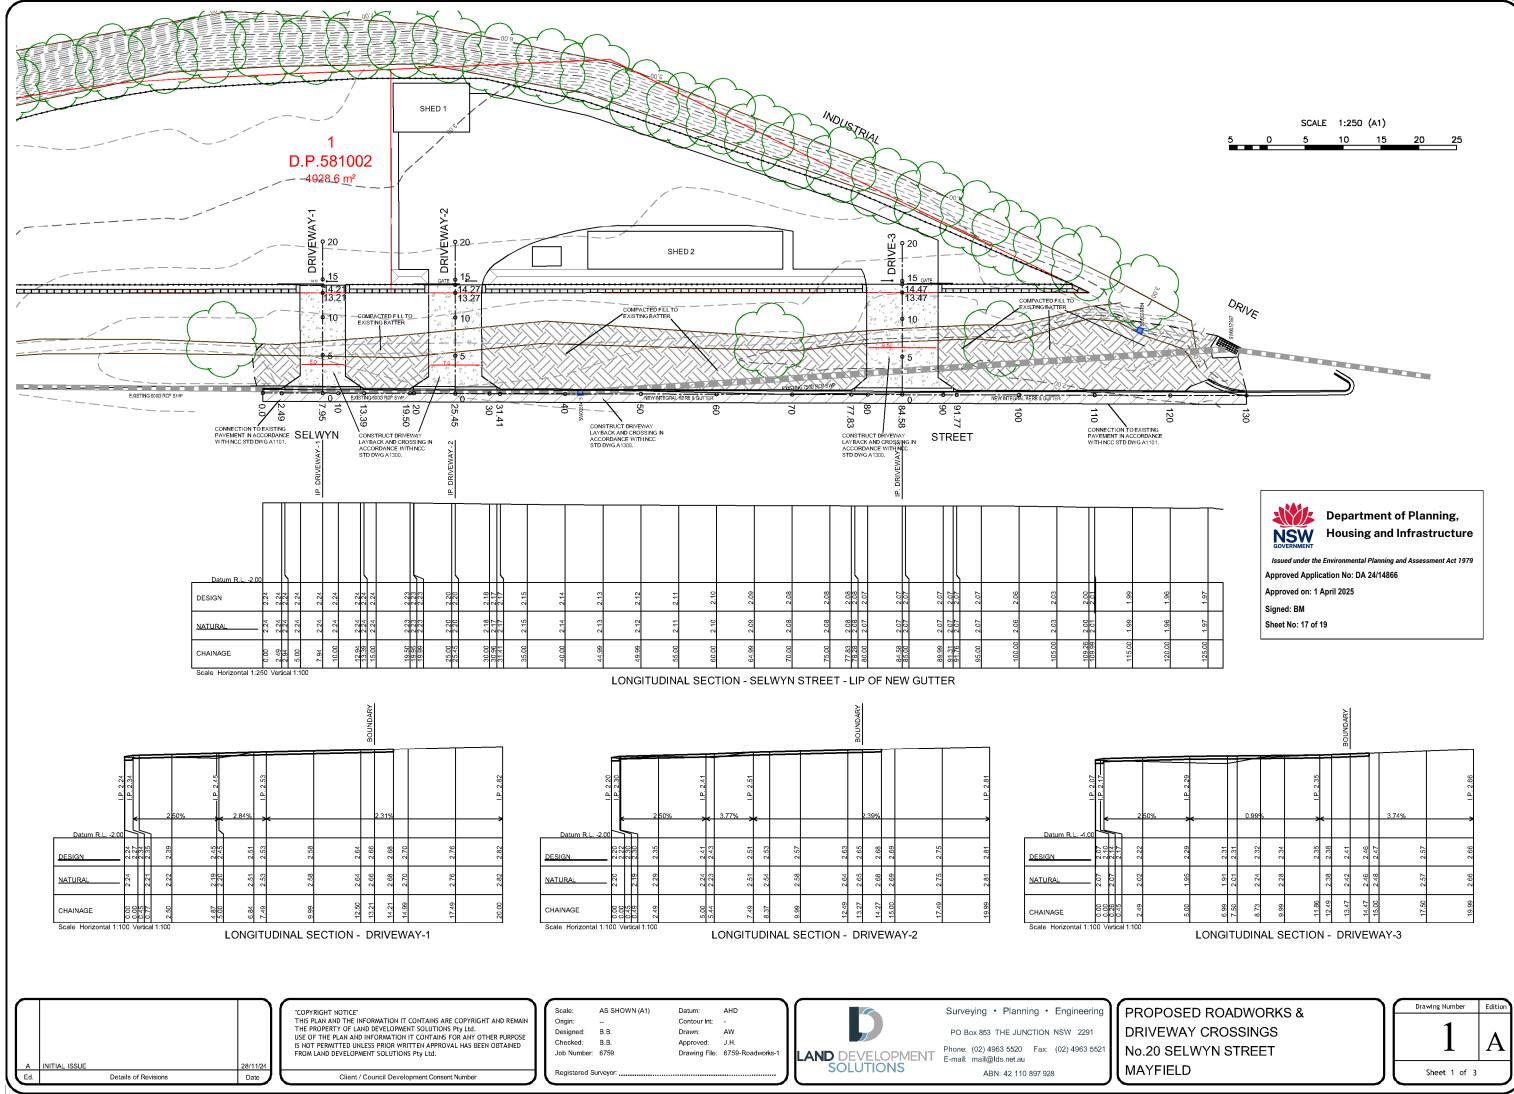


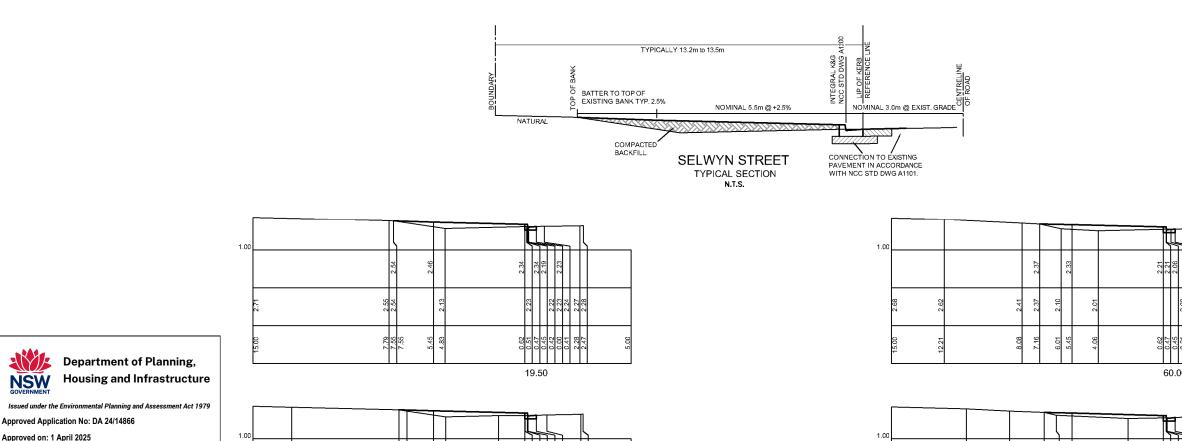




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Approved on: 1 April 2025 Signed: BM

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INITIAL ISSUE 28/11/24 Details of Revisions Date	"COPY RIGHT NOTICE" THIS PLAN AND THE INFORMATION IT CONTAINS ARE COPYRIGHT AND REMAIN THE PROPERTY OF LAND DEVELOPMENT SOLUTIONS Pty Ltd. USE OF THE PLAN AND INFORMATION IT CONTAINS FOR ANY OTHER PURPOSE IS NOT PERMITTED UNLESS PRIOR WRITTEN APPROVAL HAS BEEN OBTAINED FROM LAND DEVELOPMENT SOLUTIONS Pty Ltd. Client / Council Development Consent Number	Scale:       AS SHOWN (A1)       Datum:       AHD         Origin:        Contour Int:       -         Designed:       B.B.       Drawn:       AW         Checked:       B.B.       Approved:       J.H.         Job Number:       6759       Drawing File:       6759-Roadworks-1         Registered Surveyor:	Surveying • Planning • Engineering PO Box 853 THE JUNCTION NSW 2291 Phone: (02) 4963 5520 Fax: (02) 4963 5521 E-mail: mail@lds.net.au ABN: 42 110 897 928

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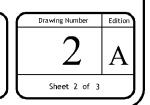
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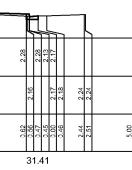
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PRELIMINARY CROSS SECTIONS, SELWYN STREET - 1 No.20 SELWYN STREET MAYFIELD

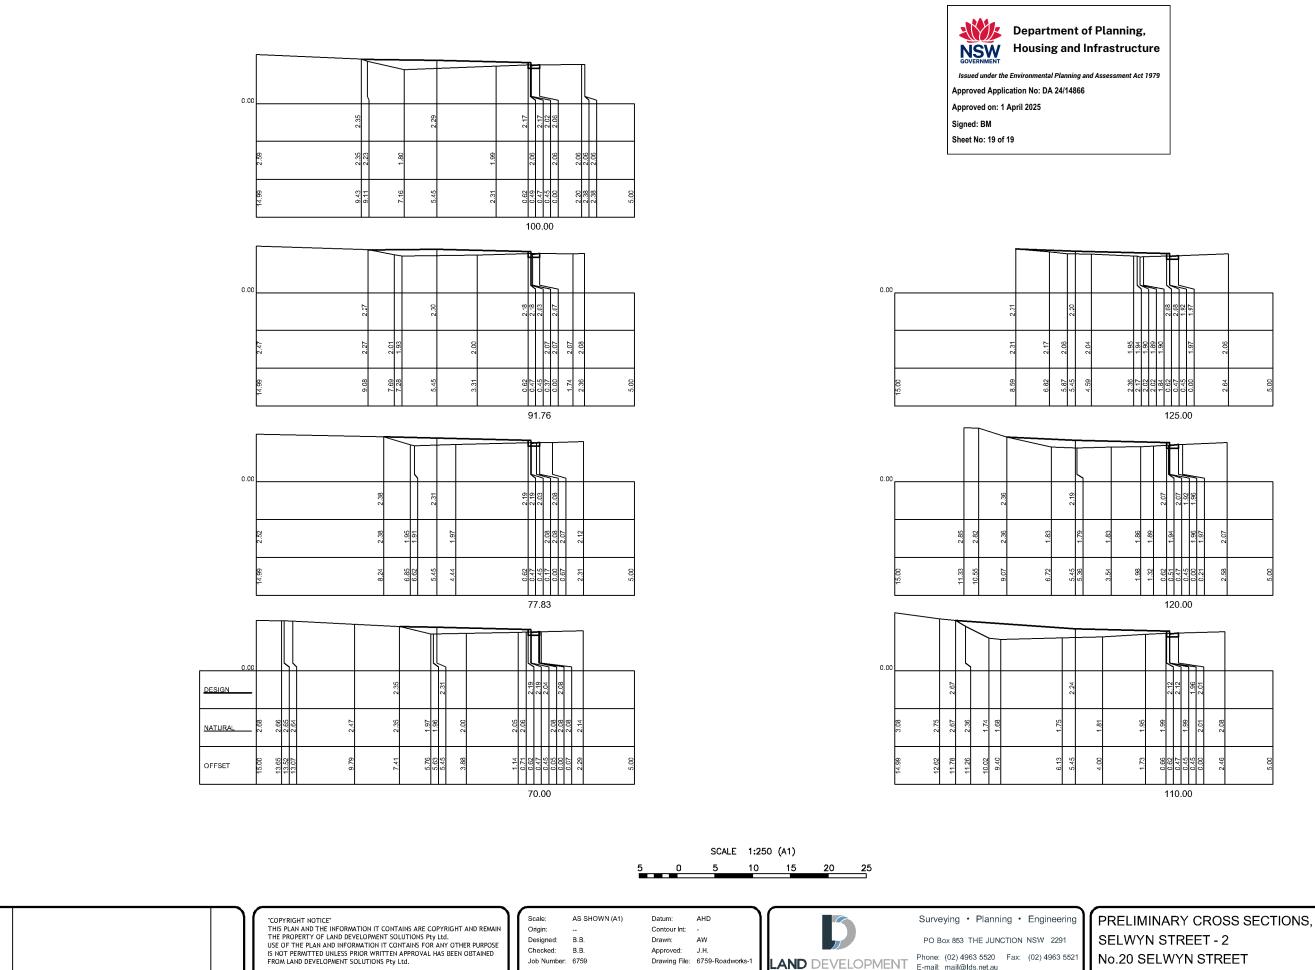




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Job Number: 6759

Registered Surveyor: "

28/11/24 Date

Client / Council Development Consent Number

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Details of Revisions

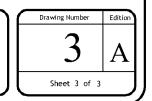
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